
CONSTRUCTION PLANS FOR

SUMNER GROVE SUBDIVISION

OWNER:

CHARLES GANT
14397 CREOSOTE ROAD
GULFPORT, MS 39503

SECTION 13 TOWNSHIP 8 SOUTH RANGE 12 WEST CITY OF LONG BEACH HARRISON COUNTY MISSISSIPPI

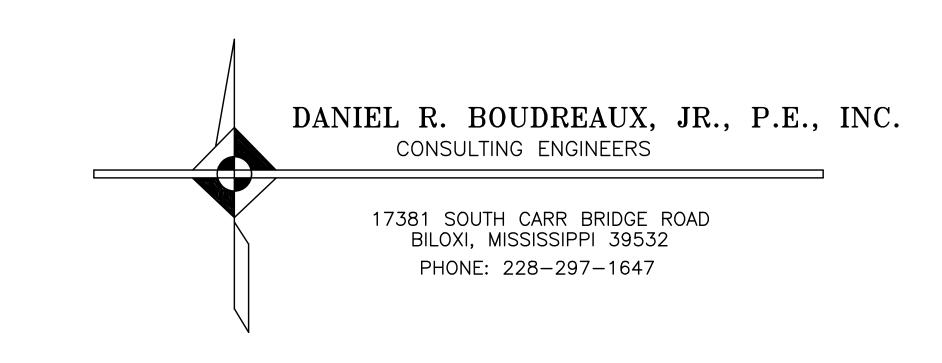

SHEET INDEX

| SHEET NO. | TITLE |
|-----------|----------------------|
| 1 | TITLE SHEET |
| 2 | EXISTING TOPO |
| 3 | LOT LAYOUT |
| 4 | ROAD & DRAINAGE PLAN |
| 5 | STORMWATER POLLUTION |
| | PREVENTION PLAN |
| 6 | UTILITY PLAN |
| 7 | ROAD PLAN/PROFILE |
| 8 | CONSTRUCTION DETAILS |
| 9 | CONSTRUCTION DETAILS |
| 10 | CONSTRUCTION DETAILS |
| 11 | CONSTRUCTION DETAILS |
| 12 | CONSTRUCTION DETAILS |
| 13 | CONSTRUCTION DETAILS |
| | |


AUGUST 01, 2021



VICINITY MAP

SCALE: N.T.S.

GENERAL LAYOUT

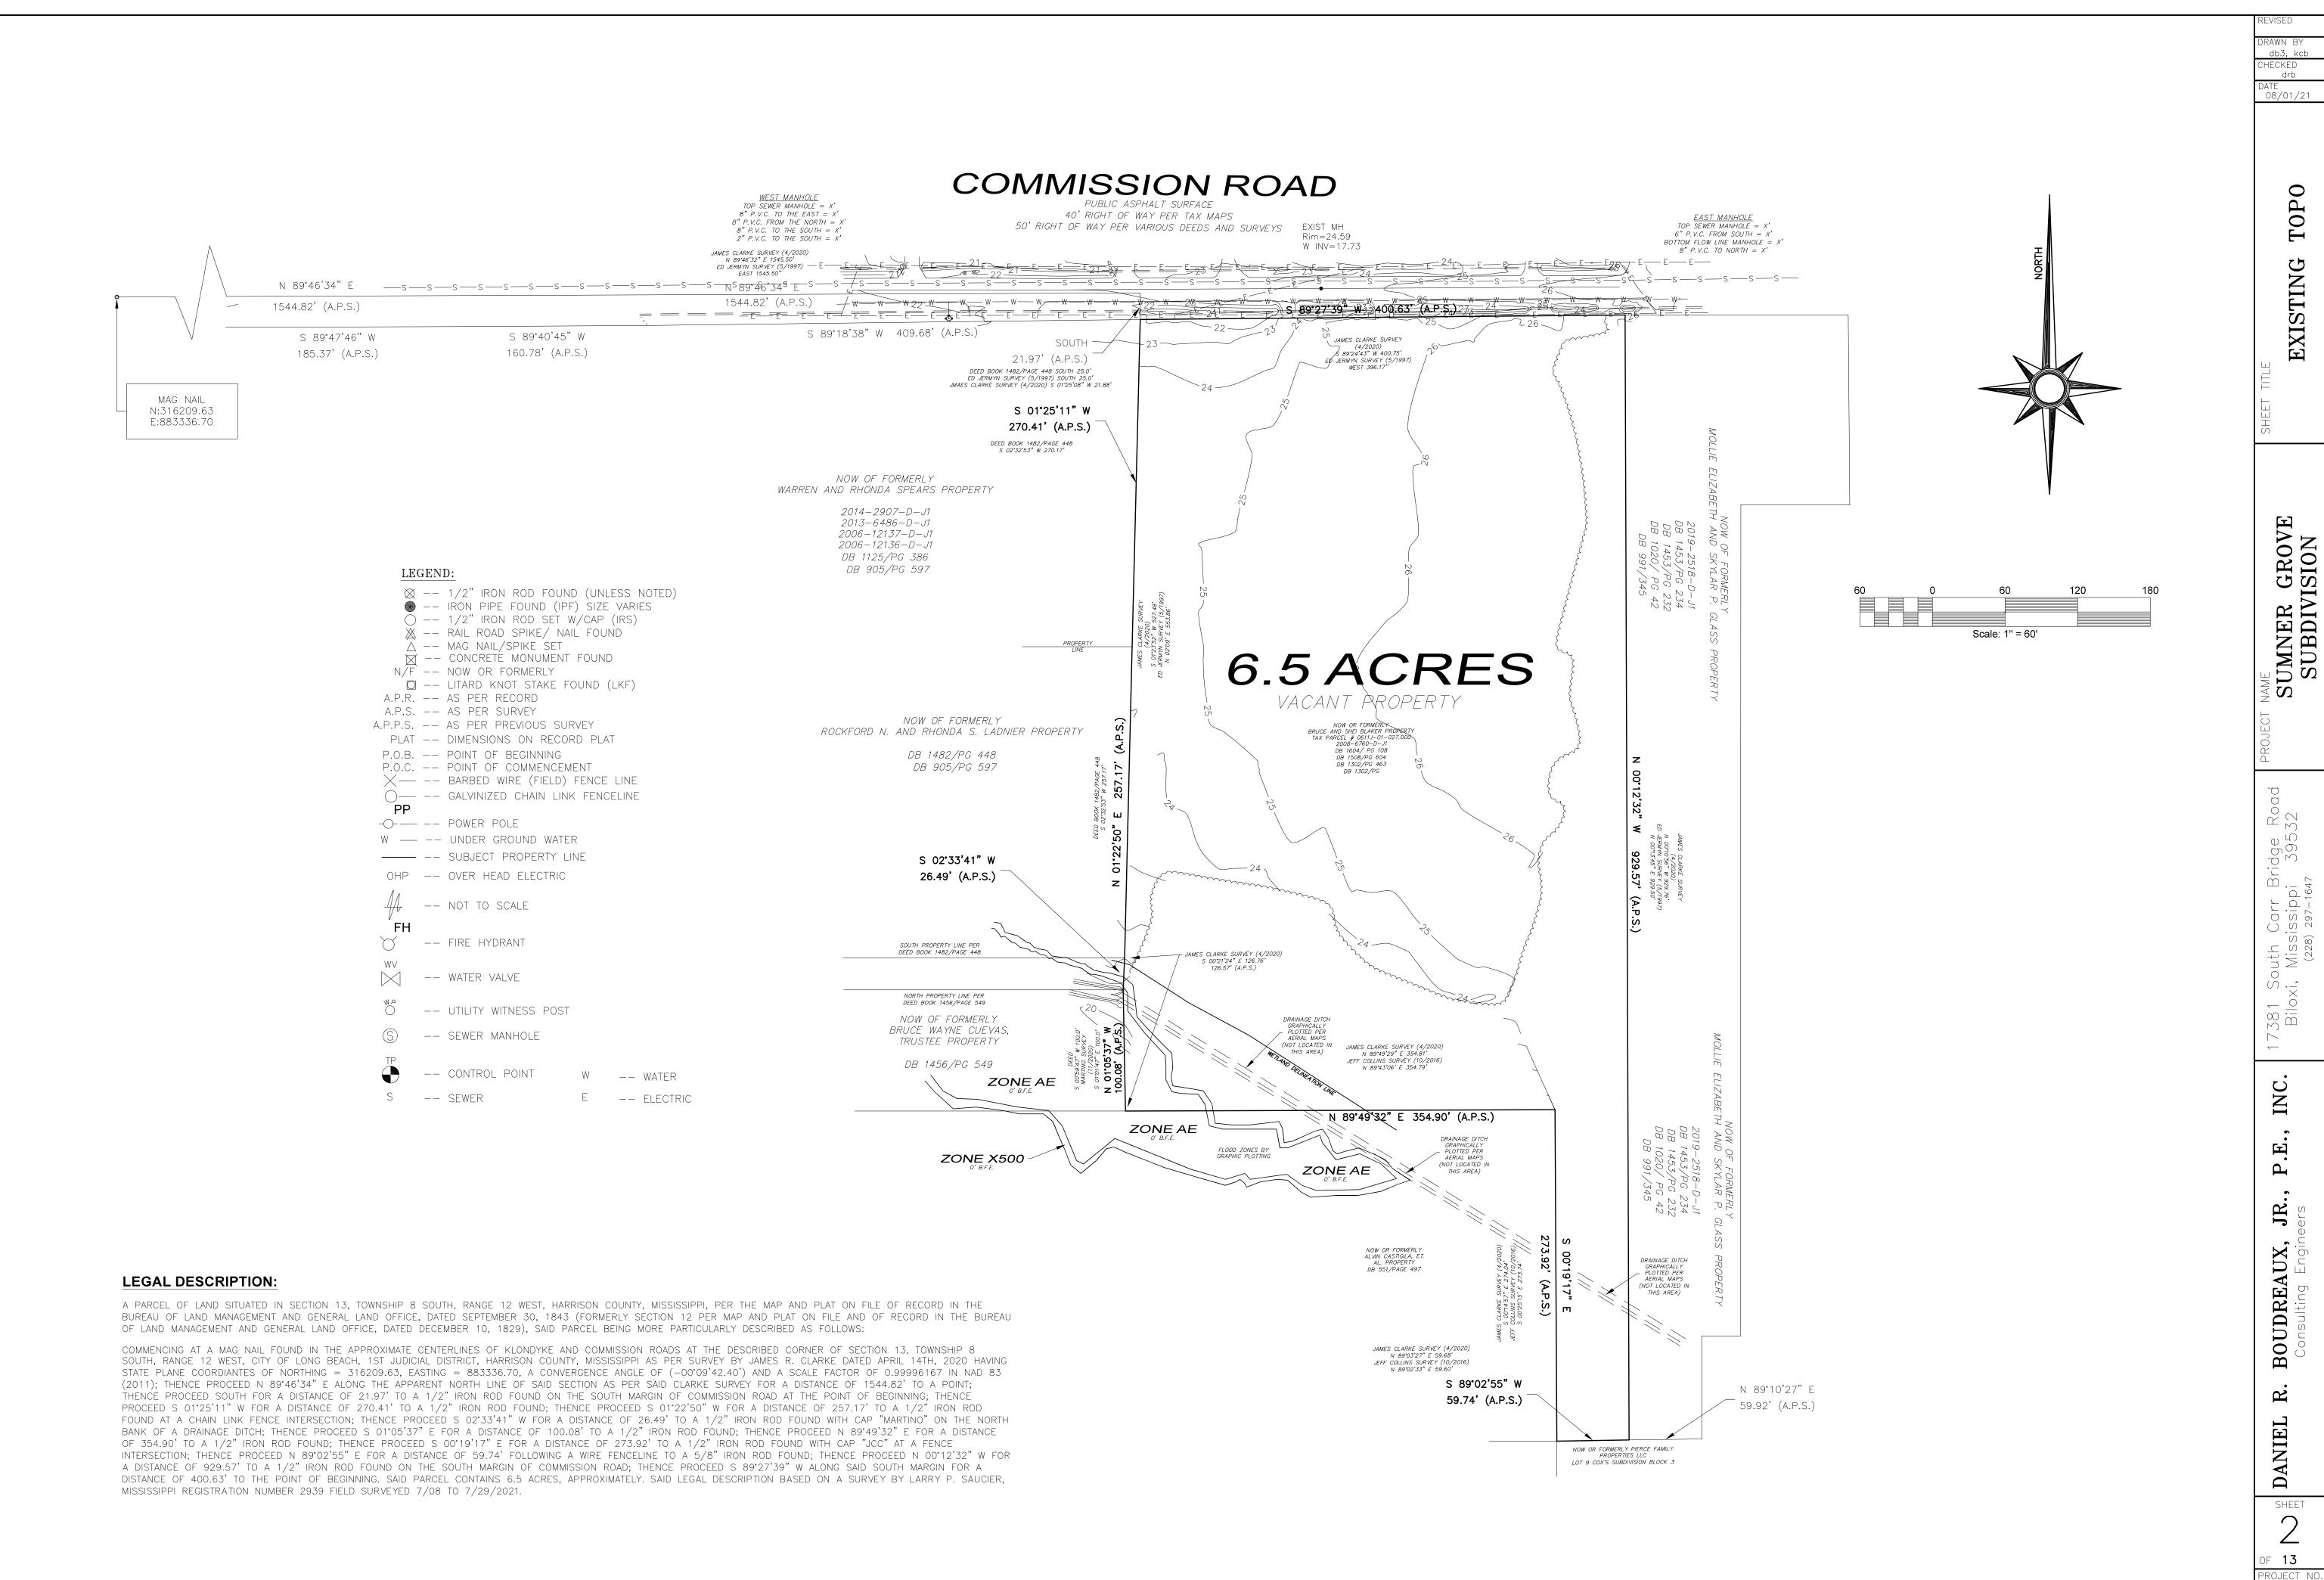

STORM WATER POLLUTION PREVENTION NOTES:

1.) AVOID DISTURBING AREA UPSLOPE OF WETLANDS OR DRAINS.

2.) SILT FENCING SHALL BE INSTALLED ALONG BOUNDARIES OF DISTURBED AREAS WITHIN 50' OF WETLAND AREAS.

3.) DISTURBED AREAS SHALL BE FERTILIZED, SEEDED, AND MULCHED WITHIN SEVEN CALENDAR

- 4.) PLACE TEMPORARY CONSTRUCTION ENTRANCE AT SITE ACCESS POINTS.
- 5.) SITE SHALL BE GRADED TO PROMOTE POSITIVE DRAINAGE FLOW.

6.) PROTECTION OF WORK: THE CONTRACTOR IS TO BE SOLELY RESPONSIBLE FOR THE PROTECTION OF HIS WORK. SUCH GRADING IS THE RESPONSIBILITY OF THE CONTRACTOR AND WILL BE AT NO ADDITIONAL COST TO THE OWNER. THE OWNER MAY DIRECT THE CONTRACTOR TO PERFORM NECESSARY GRADING AND DRAINAGE TO PREVENT SURFACE RUN OFF FROM DAMAGING THE WORK.

7.) CONTRACTOR SHALL VERIFY THE RECEIPT OF A WETLAND FILL PERMIT BEFORE ANY WORK IN OR DIRECTLY ADJACENT TO WETLAND AREAS.


8.) THIS SKETCH IS NOT INCLUSIVE AND THE CONTRACTOR SHALL IMPLEMENT CONTROLS AS NEEDED TO PREVENT EROSION AND ADVERSE IMPACTS TO RECEIVING STREAMS.


9.) INSPECT EROSION AND SEDIMENT CONTROLS WEEKLY AND AFTER EACH RAIN EVENT. CLEAN AND MAINTAIN EROSION CONTROLS AS REQUIRED.

10.) TOPSOIL SHALL BE STOCKPILED AND USED IN AREAS THAT WILL BE RE—VEGETATED. WHEN FINAL GRADE IS REACHED, DISTRIBUTE TO A MINIMUM DEPTH OF 2 INCHES ON 3:1 SLOPES AND 4 INCHES ON FLATTER SLOPES.


11.) HEAVY EQUIPMENT USE IN AREAS TO BE RE-VEGETATED SHALL BE AVOIDED. IF COMPACTION CANNOT BE AVOIDED, THE TOP 4 INCHES OF THE SOIL BED SHOULD BE TILLED BEFORE RE-VEGETATION. ANY NECESSARY FERTILIZER OR OTHER SOIL AMENDMENTS SHOULD BE ADDED DURING THE TILLING PROCESS.

12.) CONTRACTOR SHALL REMOVE TEMPORARY SWPPP MEASURES UPON ESTABLISHMENT OF PERMANENT CONTROLS SUCH AS A HEALTHY STAND OF GRASS. RESPONSIBILITY WILL BE TRANSFERED TO BUILDING CONTRACTOR FOR THOSE AREAS REQUIRED FOR HIS WORK UPON ACCEPTANCE BY ENGINEER.

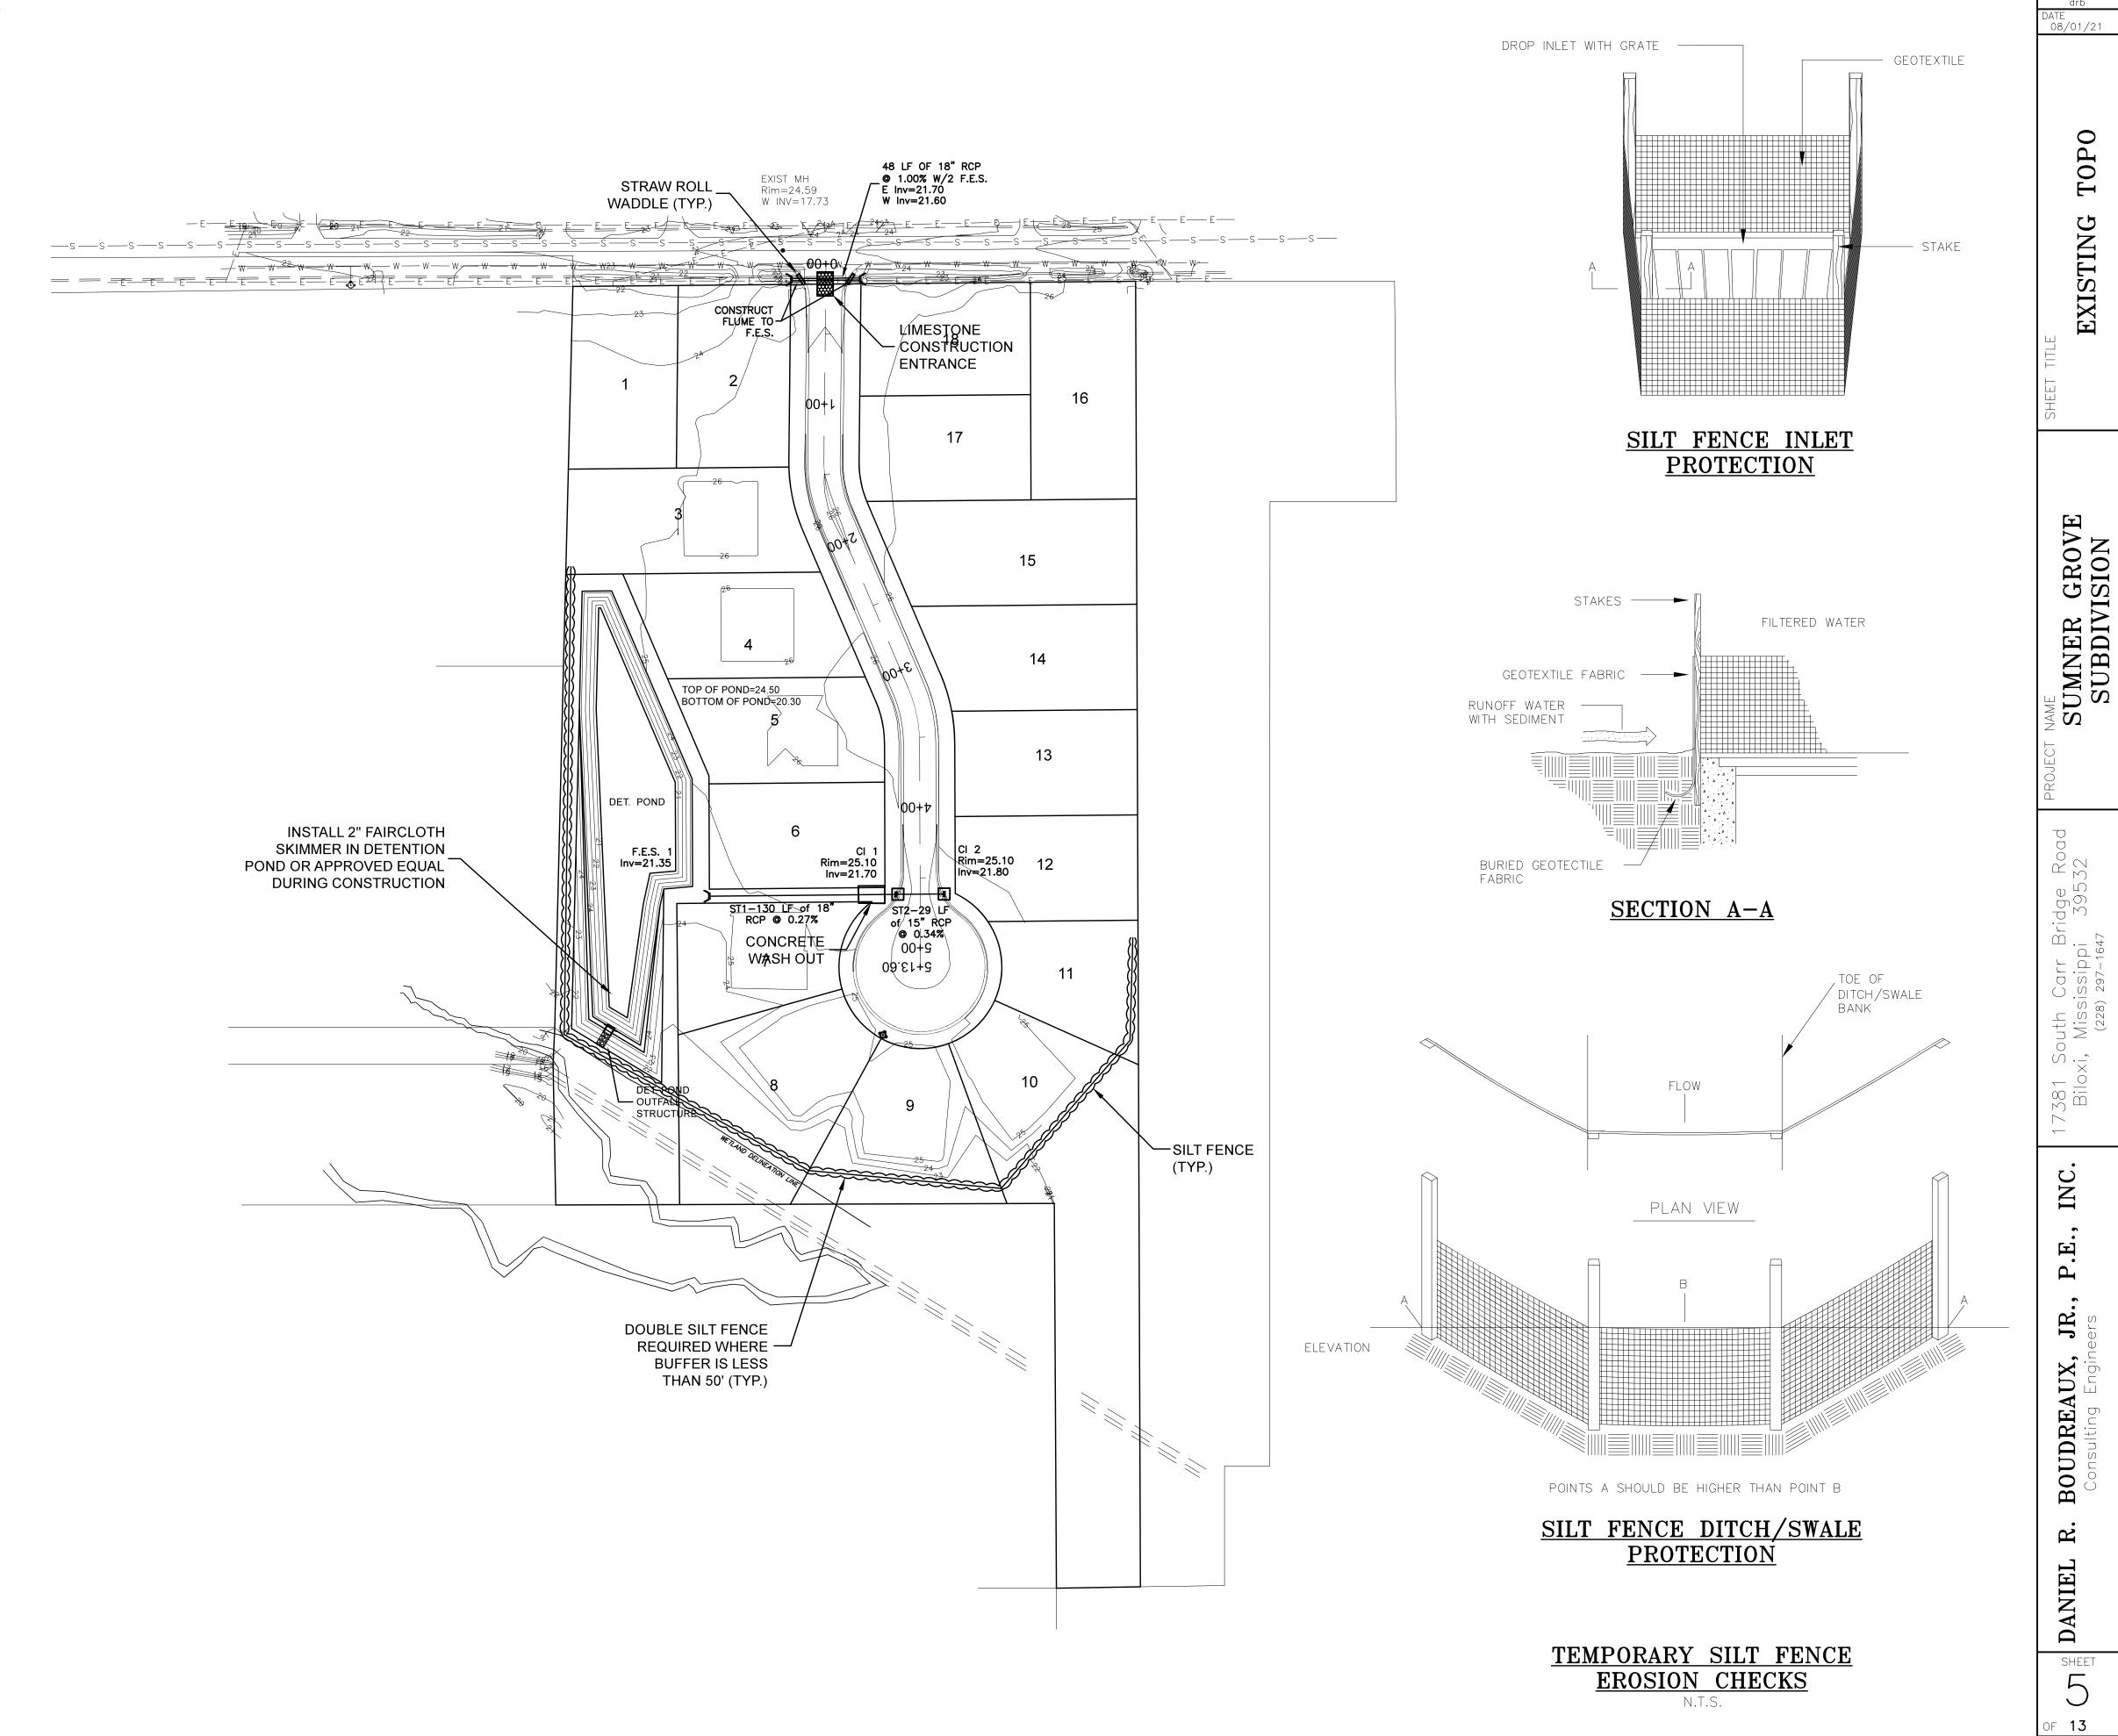

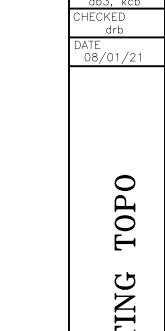


SUMNER GROVE SUBDIVISION

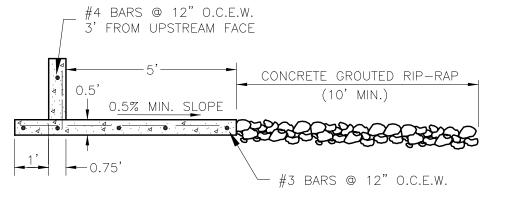


NOTE: DURING CONSTRUCTION INSTALL A 2" FAIRCLOTH SKIMMER FOR ALL PONDS.


SECTION BB N.T.S.

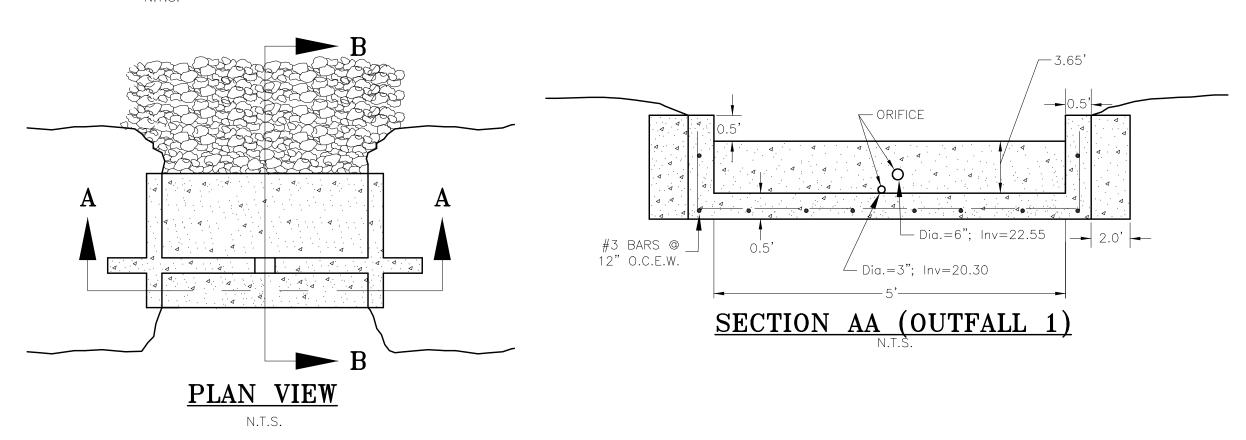


DETENTION POND OUTFALL STRUCTURE N.T.S.

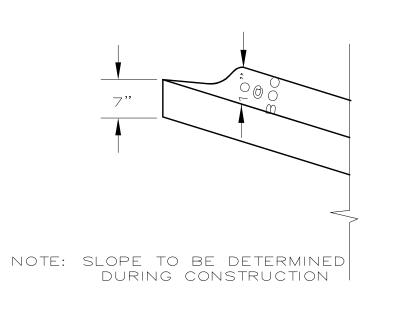


SECTION B-B

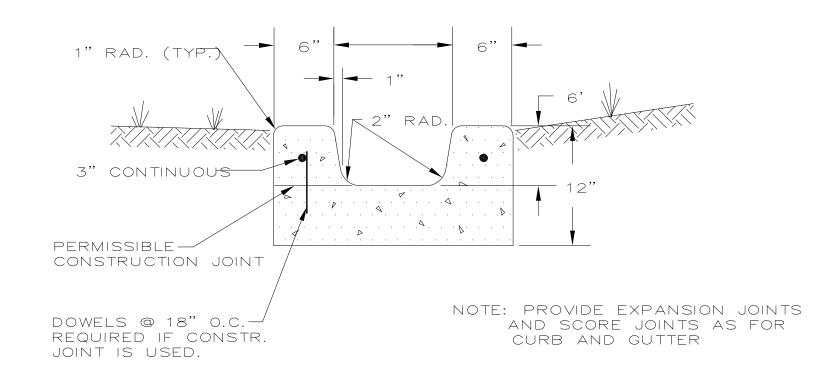


SECTION A-A

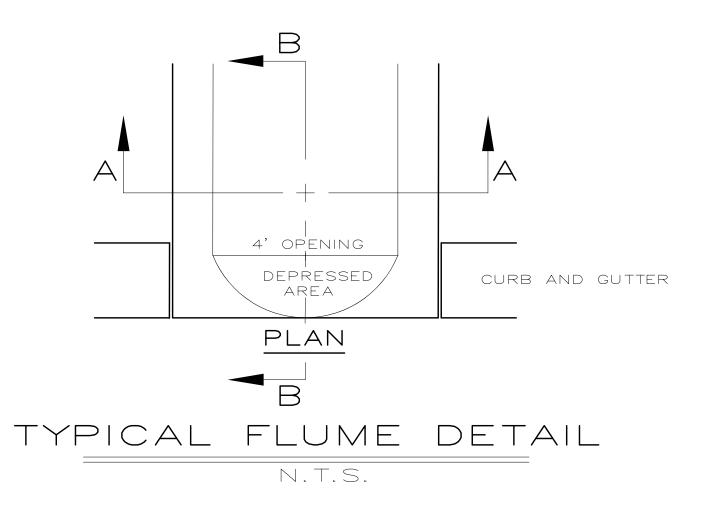


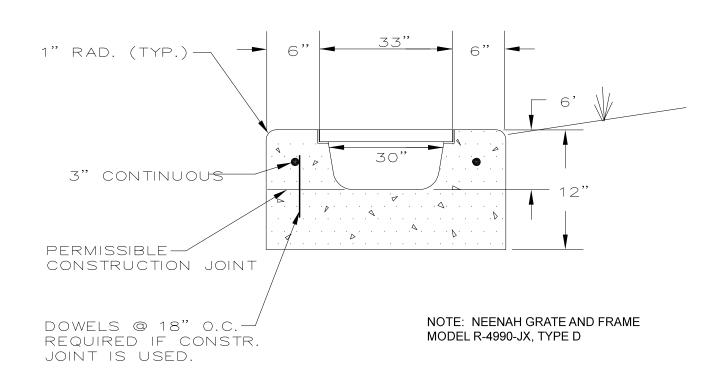

SIDEWALK CROSSING FLUME

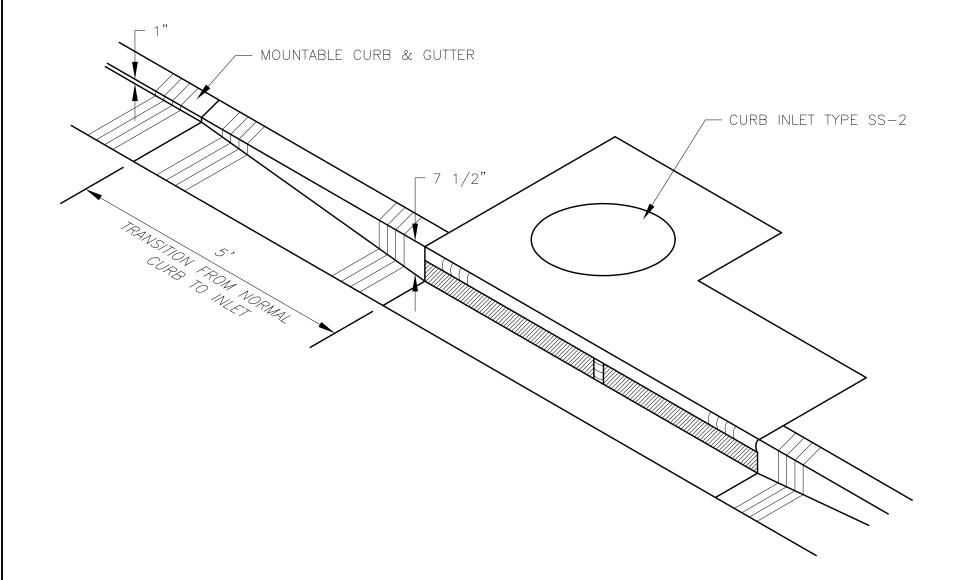

THROAT DETAIL OF MOUNTABLE (ISOMETRIC) N.T.S.

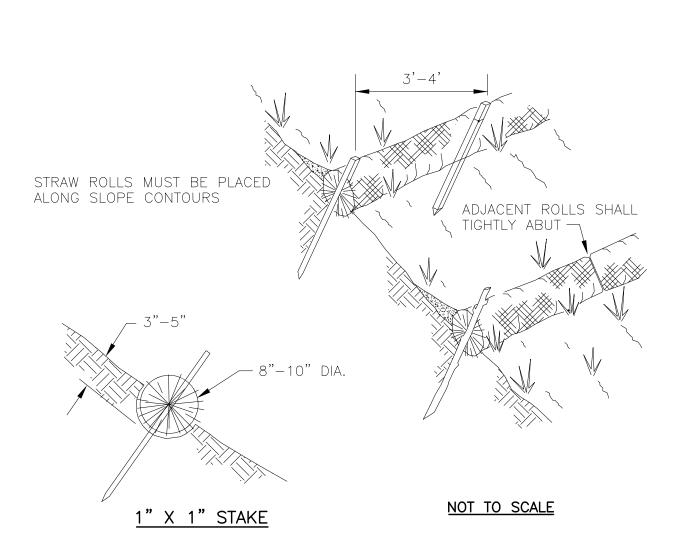

1. STRAW ROLL INSTALLATION REQUIRES THE PLACEMENT AND SECURE STAKING OF THE ROLL IN A TRENCH, 3"-5" DEEP, DUG ON CONTOUR. RUNOFF MUST NOT BE ALLOWED TO RUN UNDER OR AROUND ROLL.

STRAW ROLL WATTLE DETAIL